


Architect
Thomas Paino
45-14 11 St.
Long Island City, NY 11101


Contractor

Structural Engineer

MEP Engineer

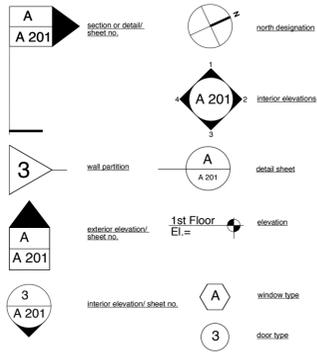

NOTES/ LEGEND

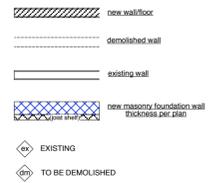



SITE PLAN/LEGEND



STRUCTURAL NOTE/LEGEND

- (TYPICAL UNLESS OTHERWISE NOTED)
- TYPICAL HEADER (U.O.N.) (2' X 10' (U.O.N.) UNLESS OTHERWISE NOTED)
 - BEAM (S NOTED)*
 - TYPICAL FLOOR JOIST
FLOOR JOIST @ 16" O.C.
 - TYPICAL CEILING JOIST
FLOOR JOIST @ 16" O.C.
 - TYPICAL ROOF RAFTER
FLOOR JOIST @ 16" O.C.
 - 4x4 WOOD POST (DOUBLE 2X TO MATCH WALL THICKNESS U.O.N.)
POST/COLUMN ABOVE
BEAM HANGER**
 - EXISTING COLUMN
 - STEEL POST 4" radius diameter standard weight steel per AISC 360
 - 5/8" DIAMETER ANCHOR BOLTS
 - SHEAR WALL CONNECTOR- EVERY CORNER AND JACK STUD
- NEW CONVENTIONAL FRAMING TO BE DOUGLAS FIR LARCH #2 MIN.
- * BEAM TAG []
- ** CRITICAL PATH DIAGRAM TRAPPING AND TYPICAL HANGER

NOTES/LEGEND

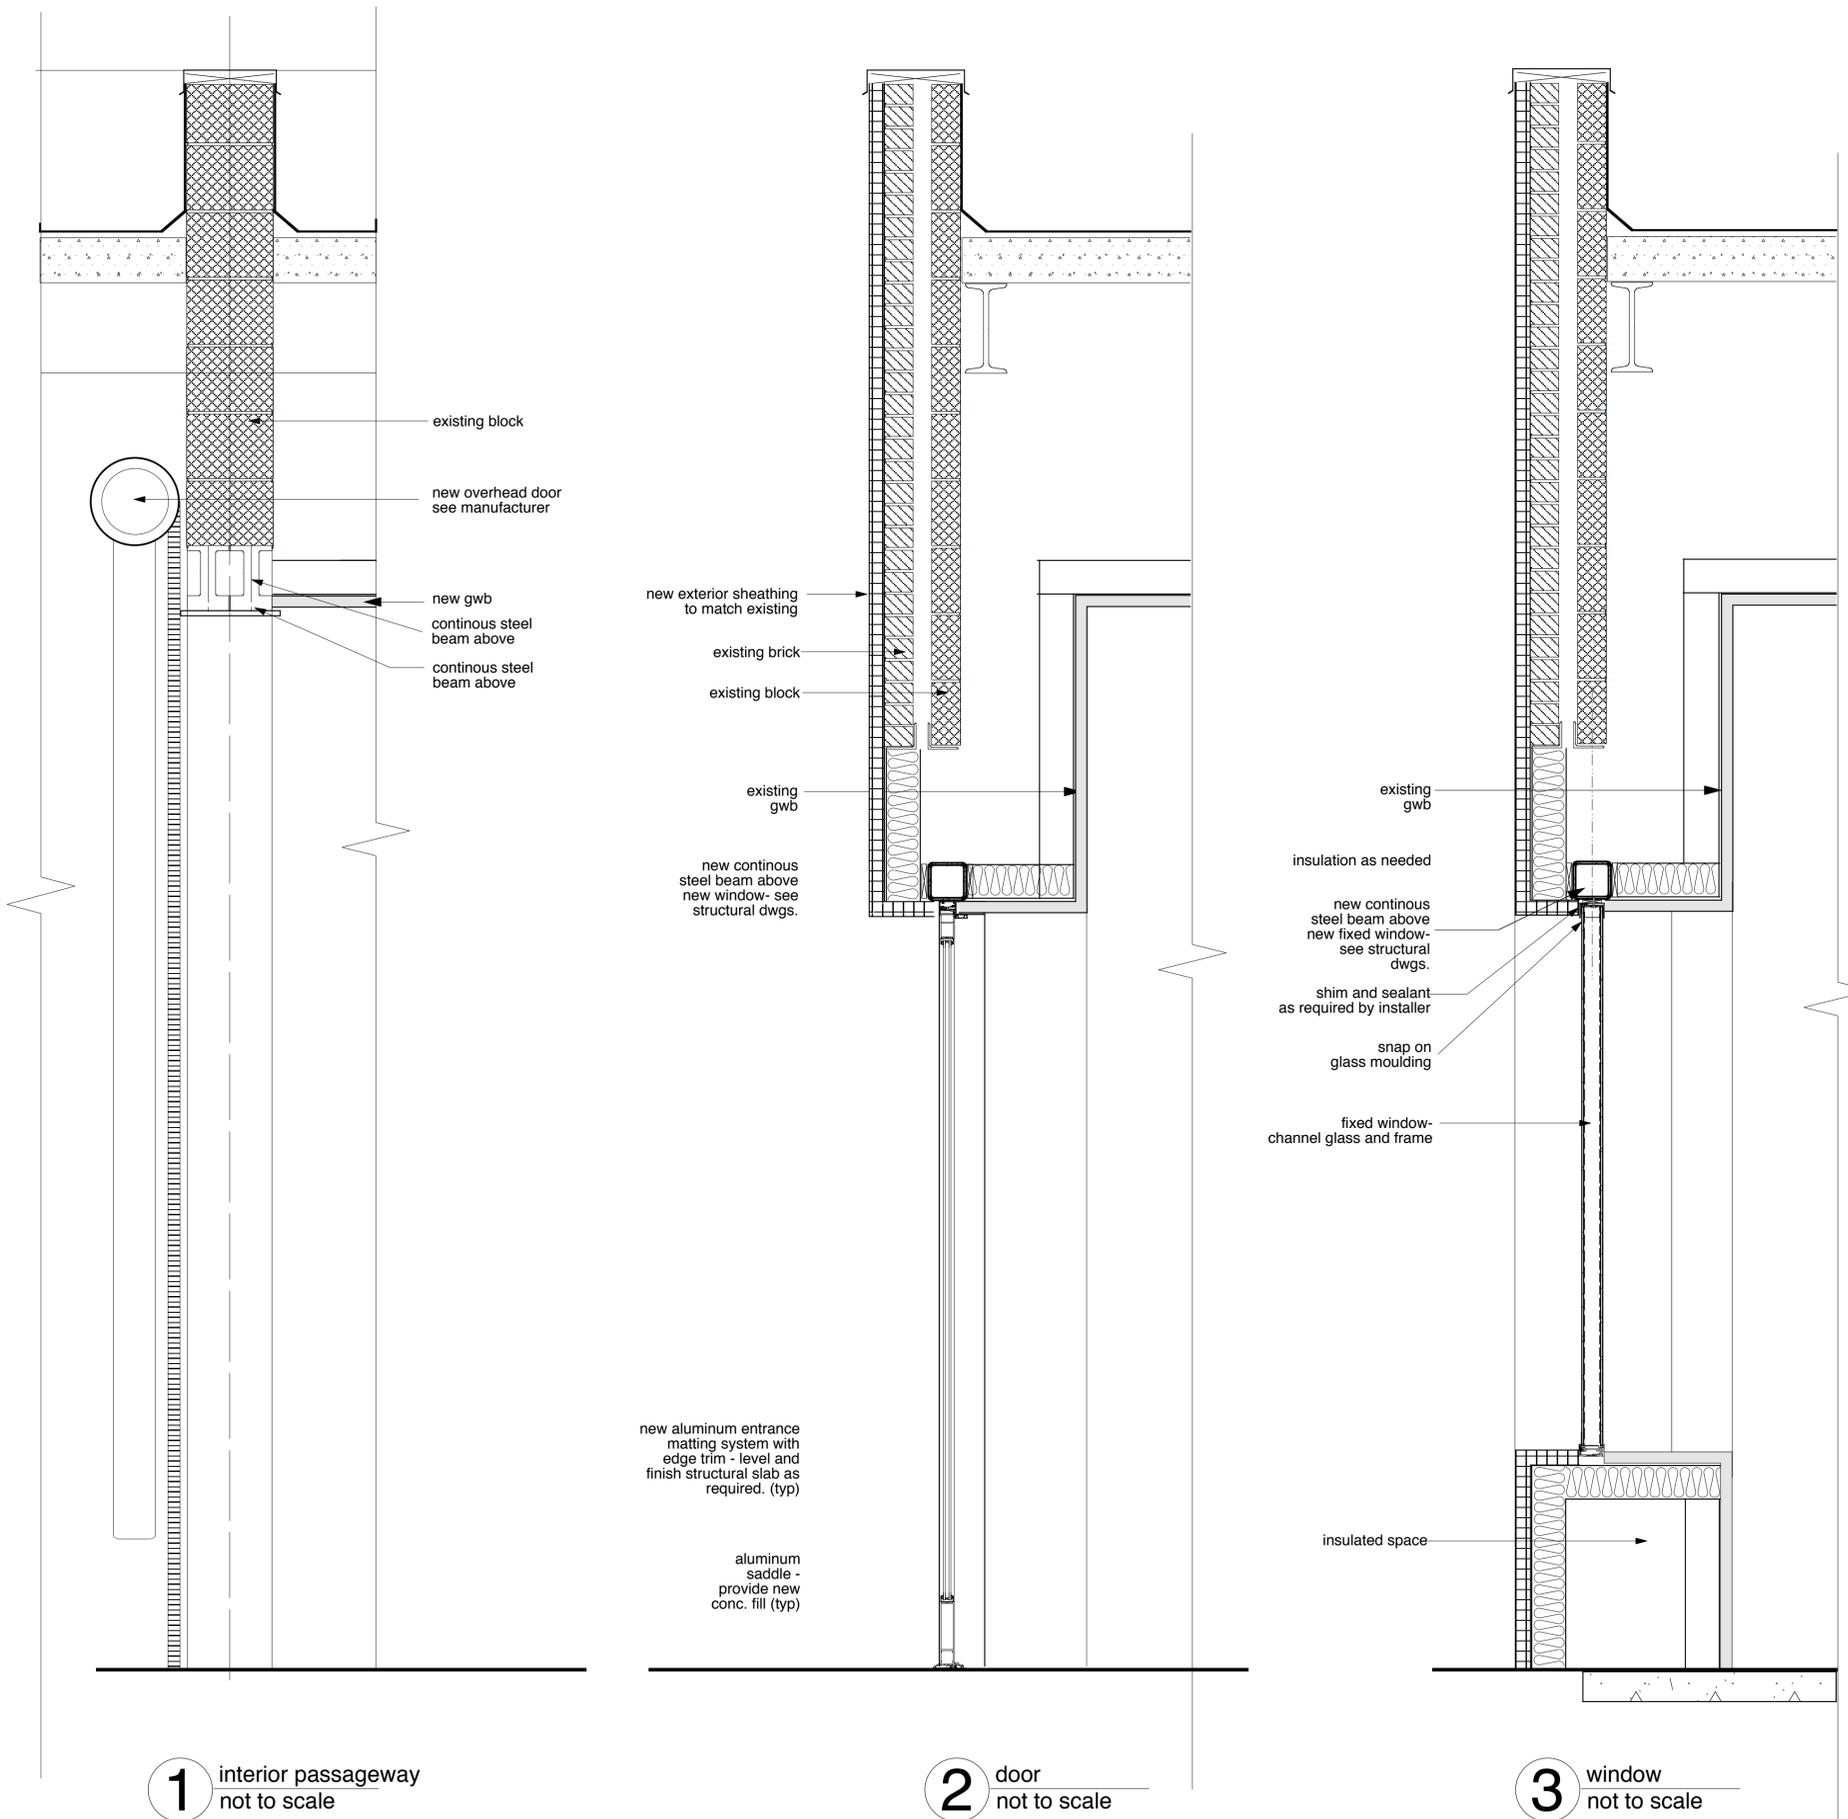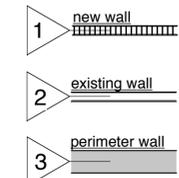

1 interior passageway
not to scale

2 door
not to scale

3 window
not to scale

REVISIONS/ADDITIONS

NO.	DATE

DATE
6/23/18

SCALE AS NOTED

DRAWING TITLE

A-2